



PLAN VIEW - DOWN POSITION

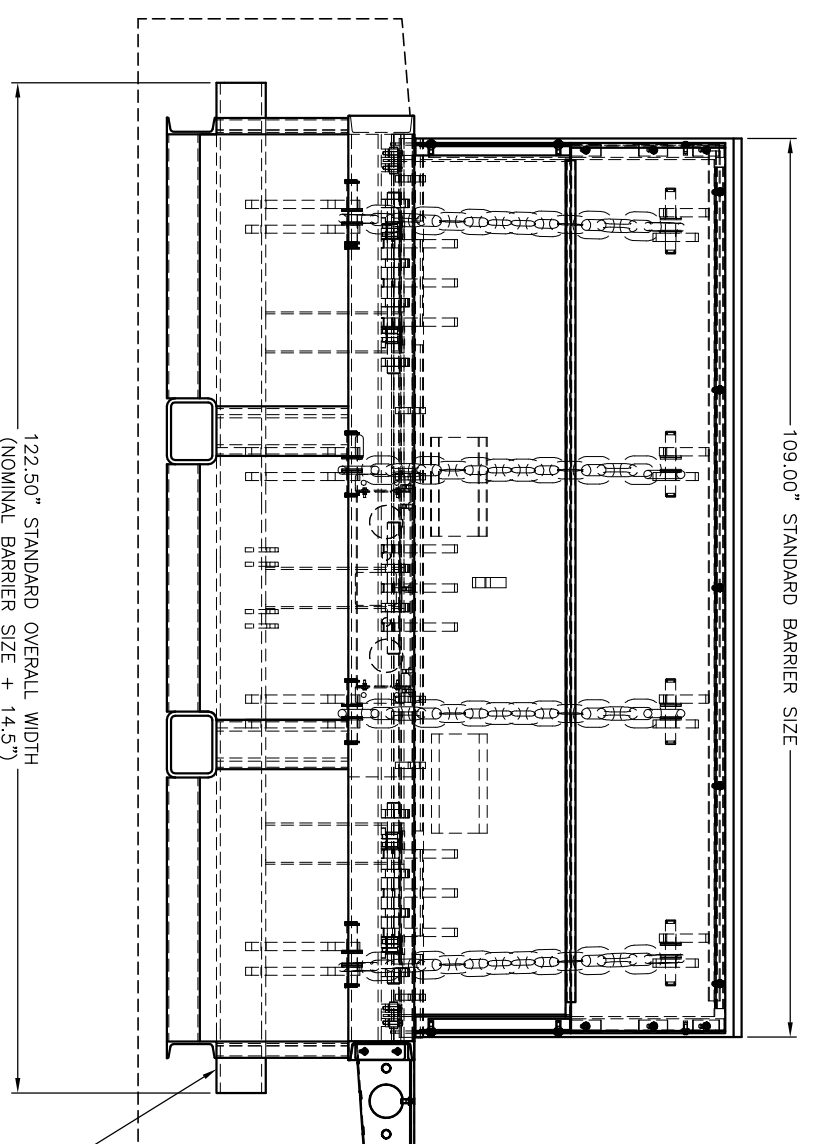

FRONT ELEVATION - UP POSITION

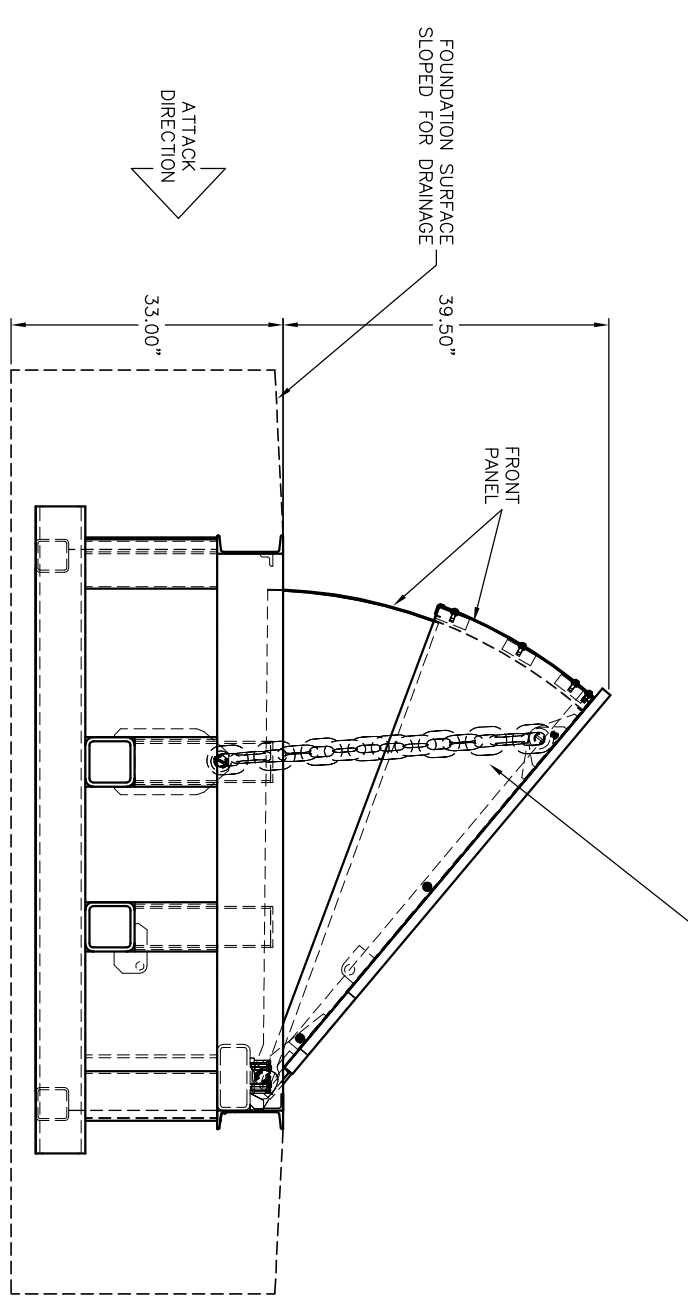

SIDE ELEVATION - UP POSITION

RAM HAS (2) 3/4" THREADED ATTACHMENT POINTS FOR LIFTING. THE ATTACHMENT MEANS BETWEEN THE BARRIER RAMP AND THE LIFTING GEAR MUST BE SIZED OR DESIGNED TO TAKE INTO CONSIDERATION BOTH VERTICAL LIFTING AS WELL AS SIDE LOADING CONDITIONS. THE USE OF PROPERLY SIZED SPREADER BARS OR DUAL VERTICAL LIFTS ARE RECOMMENDED.


- NOTES:
- OPTIONAL AVAILABLE FEATURES (PARTIAL)
 

	PART NO.
(A) HEATER, 1400 WATTS @ 120 VOLTS	B1293
(A) HEATER, 1400 WATTS @ 240 VOLTS	B1294
(B) LIMIT SWITCH, FULLY DOWN	B2005
(C) LIMIT SWITCH, FULLY UP	B2006
(D) HOT-DIP GALVANIZING PRIOR TO PAINTING	GALV
  - COLOR OPTIONS:
    - WHITE w/6" WIDE YELLOW STRIPES
    - BLACK w/6" WIDE YELLOW STRIPES
    - WHITE w/6" WIDE RED STRIPES
  - FOUNDATION - ASBESTOS FREE ASPHALT EMULSION UNDERCOAT.
  - ALL STEEL MEMBERS PER AISC STANDARDS WELDING DESIGN CRITERIA AWS D1.1, LATEST REVISION.
  - ALL MILD STEEL COMPONENTS SANDBLASTED TO NEAR WHITE METAL AFTER FABRICATION AND PRIOR TO COATING.

ACCESS BOX MAY BE MOUNTED ON EITHER SIDE

ANTI-SLIP FINISH ON BARRIER SURFACE

CRASH ARRESTING CHAIN SYSTEM

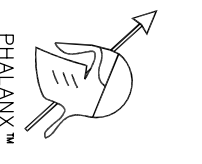

PHALANX™

THE DRAWING, UNLESS OTHERWISE NOTED, REMAINS THE PROPERTY OF DELTA SCIENTIFIC CORPORATION. REPRODUCTION OR USE FOR ANY OTHER PURPOSE WITHOUT THE WRITTEN PERMISSION OF DELTA SCIENTIFIC CORPORATION IS PROHIBITED. ANY UNAUTHORIZED REPRODUCTION OR USE OF THIS DRAWING, WITHOUT THE WRITTEN PERMISSION OF DELTA SCIENTIFIC CORPORATION, IS PROHIBITED AND SUBJECT TO LEGAL ACTION.

UNLESS OTHERWISE NOTED DIMENSIONS ARE IN INCHES

TOLERANCES  
 .X = ±.250/FT  
 .XX = ±.025/FT  
 .XXX = ±.015/FT

**DELTA SCIENTIFIC CORPORATION**  
 40355 DELTA LANE  
 PALMDALE, CA 93551 U.S.A.  
 (661) 575-1100 FAX (661) 575-1109

**DSC207S BARRIER GENERAL ARRANGEMENT**

DESIGN BY	DATE	DRAWING NO.	REV.
J. MANOR	6/13/11	90140	-
CHECK BY	DATE		
APPROV BY	DATE	SCALE: 1:12	SHEET 1 OF 1